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CIVIL ENGINEERS & LAND SURVEYORS

April 16, 2021

Re: Revenue Producing T-Hangar (REBID)

Sigurd Anderson Field Webster, South Dakota AIP # 3-46-0059-011-2021

A-7148

Bid Opening: April 26, 2020

2:30 pm Local Time

ADDENDUM NUMBER 1

CONTRACT DOCUMENTS AND TECHNICAL SPECIFICATIONS

1. Special Conditions – SC-6. Construction Limitations, Page 20 Replace Base Bid with the following:

The Revenue Producing T-Hangar shall be completed by September 1, 2022.

The work shall be completed in accordance with Paragraph 50-15 of the General Provisions by October 1, 2022.


2. General Provisions – Section 30 Award and Execution of Contract, Page 57, Replace Item 30-02 Award of Contract paragraph one with the following:

30-02 Award of Contract. The award of a contract, if it is to be awarded, shall be made within 15 calendar days of the date specified for publicly opening proposals, unless otherwise specified herein.



PROJECT ENGINEER – HELMS & ASSOCIATES

Acknowledge receipt of the Addendum by inserting its number on the Bid Form. Failure to do so may subject bidder to disqualification. This addendum forms a part of the Contract Documents. It modifies them as above.

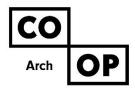

Addendum No. 1 April 16th, 2021

Project: Webster Revenue Producing T-Hangars

Architect: CO-OP Architecture

SCOPE OF THIS ADDENDUM:

To all bidders and all others to whom drawings and specifications have been issued by CO-OP Architecture.

Acknowledge receipt of this addendum by listing its number and date in the bidders Form of Proposal. Failure to do so may subject bidder to disqualification. This Addendum forms a part of the Contract Documents.

It modifies them as follows:

GENERAL ITEMS:

1. NONE AT THIS TIME

APPROVED SUBSTITUTIONS:

<u>SECTION</u>		<u>PARAGRAPH</u>	<u>SPECIFIED</u>	<u>APPROVED</u>
131200	`	Part 2.2 – C #6	Primer – FS TT-P-664	Behlen -SSPC Paint 15

REVISIONS TO DRAWINGS:

1. DRAWING SHEET A0-0

- a. ADDED WALL TYPE 5A Detail
 - i. Added note to Wall Type 5A that R-16 Minimum batt insulation shall be included in the wall cavity of Wall Type 5A
 - ii. See corresponding Wall Type 5A tags on the floor plan Sheet A1-4
- **b.** ADDED WALL TYPE 5F
 - **i.** Added note to Wall Type 5F that R-13 Minimum batt insulation shall be included in the wall cavity of Wall Type 5F.
 - ii. See corresponding Wall Type 5F tags on the floor plan Sheet A1-4
- c. ADDED Detail #2 Door Type HD (Bi-Fold Hangar Door)
- **d.** ADDED Detail #3 Door Type F Passage Door within Bi-Fold Door

2. **DRAWING SHEET A1-5**

- a. <u>Detail #1 Bi-fold hangar</u> to do be fully insulated as per manufacturer's specifications and the interior side of the bi-fold hangar door shall be sheeted in metal wall panel and painted to match all adjacent wall panels. Metal sheeting must be installed on both top and bottom half of the bi-fold hangar door, and all trim, edging, and finishes must be provided and installed as per the bi-fold hangar door manufacturer requirements.
- b. **Detail #1** Minimum R-30 Batt insulation at Roof
- c. <u>Detail #2 –</u> Eliminate stub wall detail at foundation as shown. To be constructed as shown on structural drawings reference sheet S-2.0 Detail #1 Typical Foundation Section.

d. **Detail #2** –

- i. Provide at minimum R-30 batt insulation at Roof, held in place w/ banding and Simple Saver system as basis of design.
- ii. Provide at minimum R-16 batt insulation friction fit in wall cavity for wall type5A

REVISIONS TO SPECIFICATIONS:

1.) Section 033000 – Cast-In-Place-Concrete

- a. Part 2.05 Line A
 - i. STRIKE / OMIT Fiber Reinforcement: Add to mix at rate of 1.5 pounds per cubic yard or as recommended by manufacturer for specific conditions.
 - 1. Fiber Reinforcement No longer applicable please see reinforcing requirements on the structural drawings.

2.) Section 072100 – Thermal Insulation

- a. Part 2.3 Line A
 - i. In lieu of previously published specification, Part 2.3 A will now be changed to read:
 - "Insulation at Roof: Glass Fiber, light density, thermal batt insulation conforming to ASTM C991. Provide total minimum R-Value of R-30 + R-11 liner system. Batt insulation shall be faced with a vapor barrier of foil paper, unless noted otherwise, as follows:
 - 2. Foil-Faced, Glass-Fiber Blanket Insulation: ASTM C 665, Type III (reflective faced), Class B (faced surface with a flame-propagation resistance of 0.12 W/sq. cm); Category 1 (membrane is a vapor barrier), faced with foil scrim, foil-scrim kraft, or foil-scrim polyethylene.]

b. Part 2.3 – Line B

- i. In lieu of previously published specification, Part 2.3 B will now be changed to read:
 - 1. Insulation at Walls: Glass Fiber Batt Insulation: Flexible preformed batt or blanket, complying with ASTM C665; friction fit. Minimum R-value of varies by wall type, please reference drawings sheet A0-0.

3.) Section 083431 - Part 3 - Execution

- a. STRIKE/OMIT SPECIFICATION
 - i. Installation D
 - Exterior Translucent, extruded polycarbonate sheet. NO LONGER APPLICABLE OR IN PROJECT.

4.) Section 131200 – Part 1.7 – A -Regulatory Requirements - #2

a. #2 – High Strength bolting inspection required for installations using ASTMA A 325 bolts in accordance with IBC Section 1704. Inspect bolts and surfaces prior to

installation. Verify bolt tension of a minimum of ten percent (10%) of the bolts upon completion of installation.

i. To Also Include: "Inspection is the responsibility of the General Contractor to provide and coordinate. GC to provide all documents/data to the A/E in the form of a submittal for record purposes verifying inspection."

5.) Section 131200 – Part 2 – Letter O – Wall Panels (Interior and Exterior)

- a. #1 In lieu of Interior wall panels shall be unpainted. General Contractor to provide and install all interior wall panels to be painted to match the color of the exterior metal wall panels. Reference Section 131200 – Part 2 – Letter O - #2 – Exterior Wall Panels.
- b. #3 –Thickness In lieu of Interior wall panels to be 28 gauge minimum, the specification is changed to read: Exterior Wall panels to be 26-gauge minimum. Interior wall panels to be 26-gauge minimum fabricated from steel sheets with a minimum yield strength of 50 ksi.

6.) Section 131200 – Part 2.2 – N – Roof Panels

- a. Added "Roof Panel finish color to match exterior wall panel finish (Reference Section #13120 Part 2.2 O #2
 - i. Panels shall be factory pre-painted Galvalume (with manufacturer's warranty of 20 years) with a Kynar 500 paint finish of engineer approved equal. The paint colors shall be selected by the Owner/Engineer from the manufacturers standard colors.

7.) Section 131200 - Part 2.4 - A - Framing Members: - #1

- a. All uncoated structural steel and light gauge steel members shall be cleaned of all foreign matter and loose scale and given one (1) coat of brown oxide primer. Paint shall meet or exceed Federal Specification TT-P-636.
 - i. Approved primer
 - 1. Behlen primary framing Dark Gray Primer per SSPC Paint 15
 - 2. Behlen secondary framing G40 Galvanized.

8.) Section 131200 - Part 2.8 - Accessories - D - Vented Soffit Panels


- a. ADD Letter "D" in its entirety to this section.
 - i. Vented Soffit panels to be 24 gauge vented flat soffit panels x 12" wide.


REVISIONS TO M.E.P. DRAWINGS & SPECIFICATIONS:

1.) None at this time

END OF ADDENDUM-1

As Directed by: Kody Schochenmaier – CO-OP Architecture

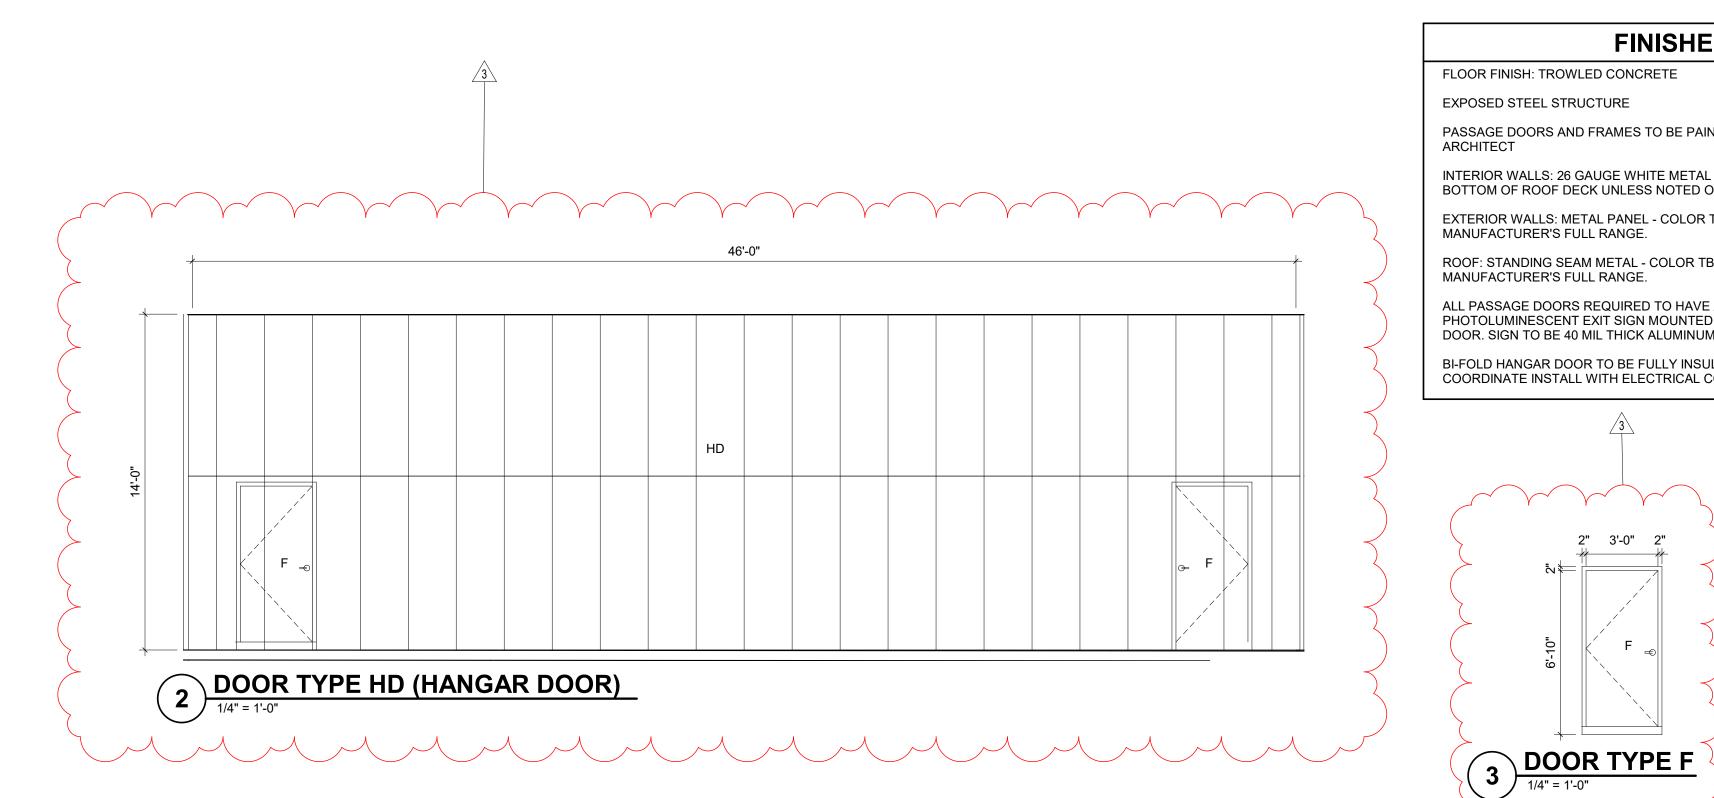


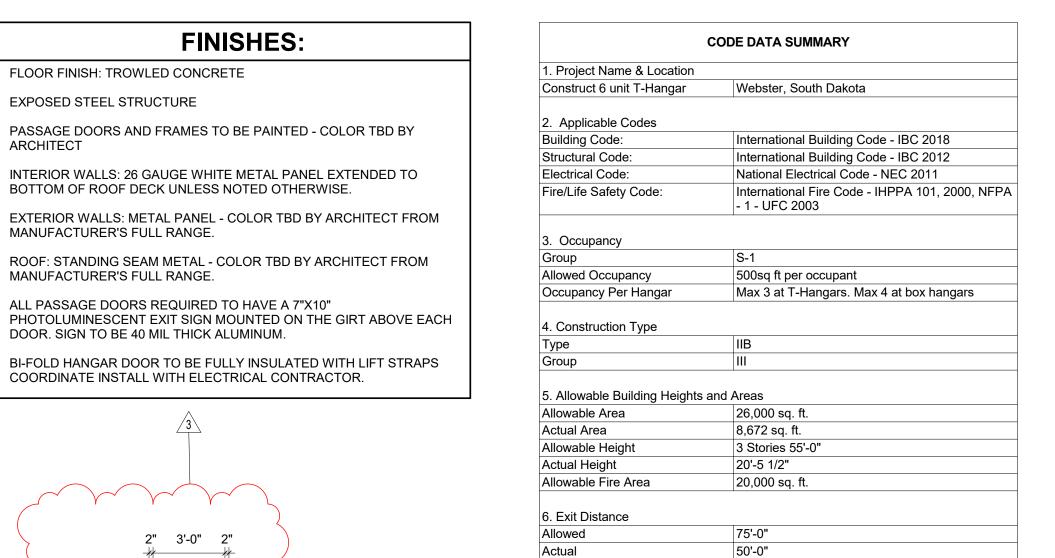


HANGAR
1
1773 SF

HANGAR
3
1195 SF

1769 SF

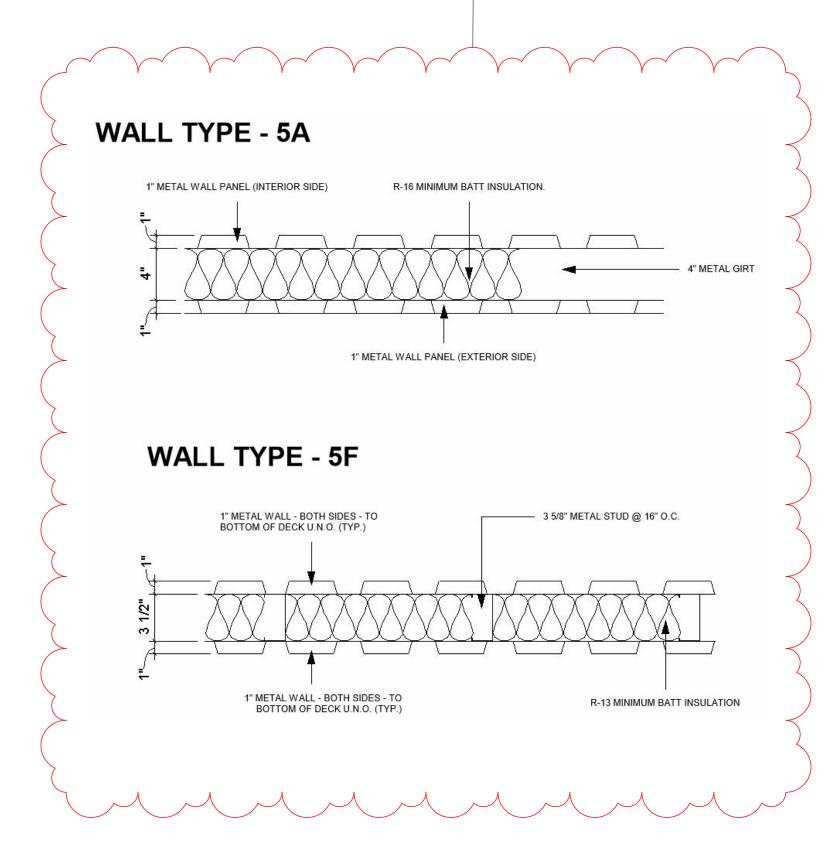

1 ORIENTATION PLAN
1/8" = 1'-0"

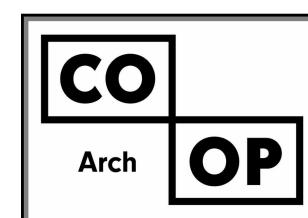


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ISSUE:

04-02-2021 100% CONSTRUCTION DOCUMENTS

REVISION SCHEDULE:

REV. # REV. DSC. REV. DATE 3 ADDENDUM #1 04-15-2021

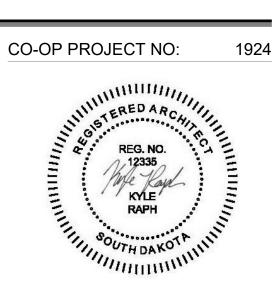
PROJECT:
WEBSTER T-HANGAR

WEBSTER, SOUTH DAKOTA


SHEET TITLE:

CODE DATA, FINISHES


A0-0

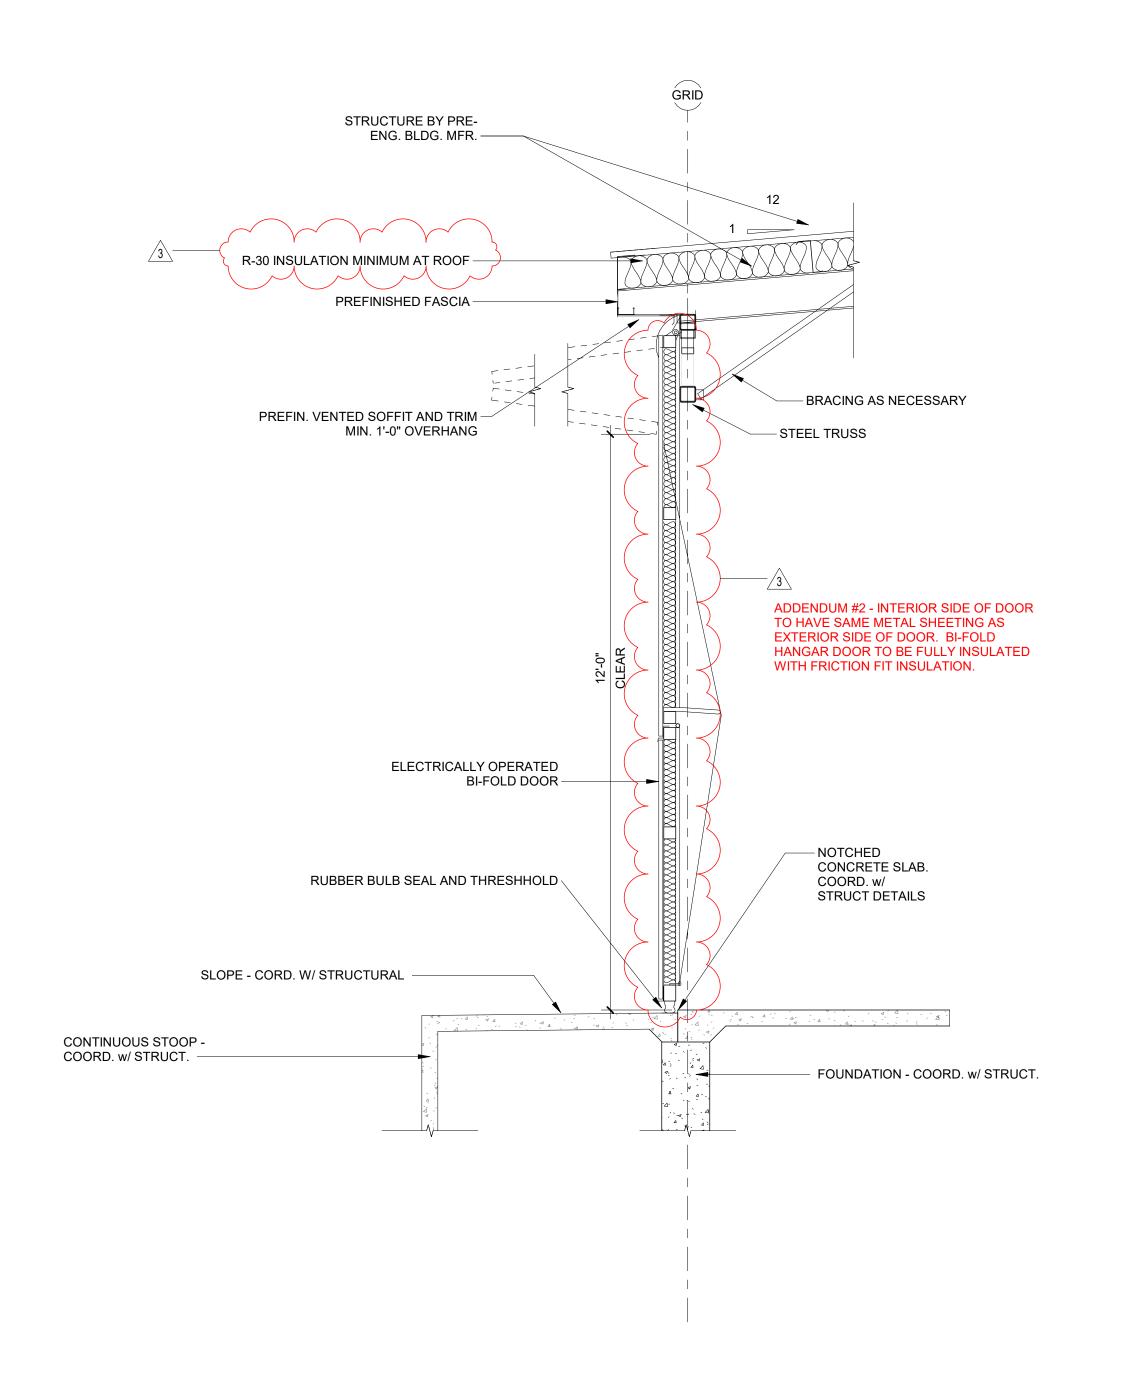

WALL SECTION AT HANGAR DOOR 1/2" = 1'-0"

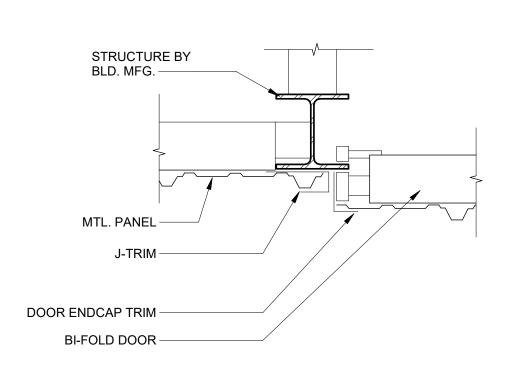


3 BI-FOLD DOOR JAMB
1 1/2" = 1'-0"

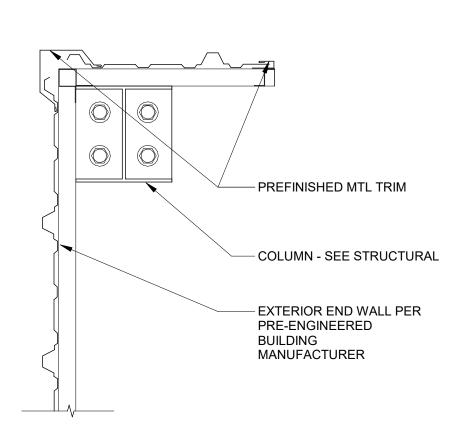


4 OUTSIDE CORNER


1 1/2" = 1'-0"

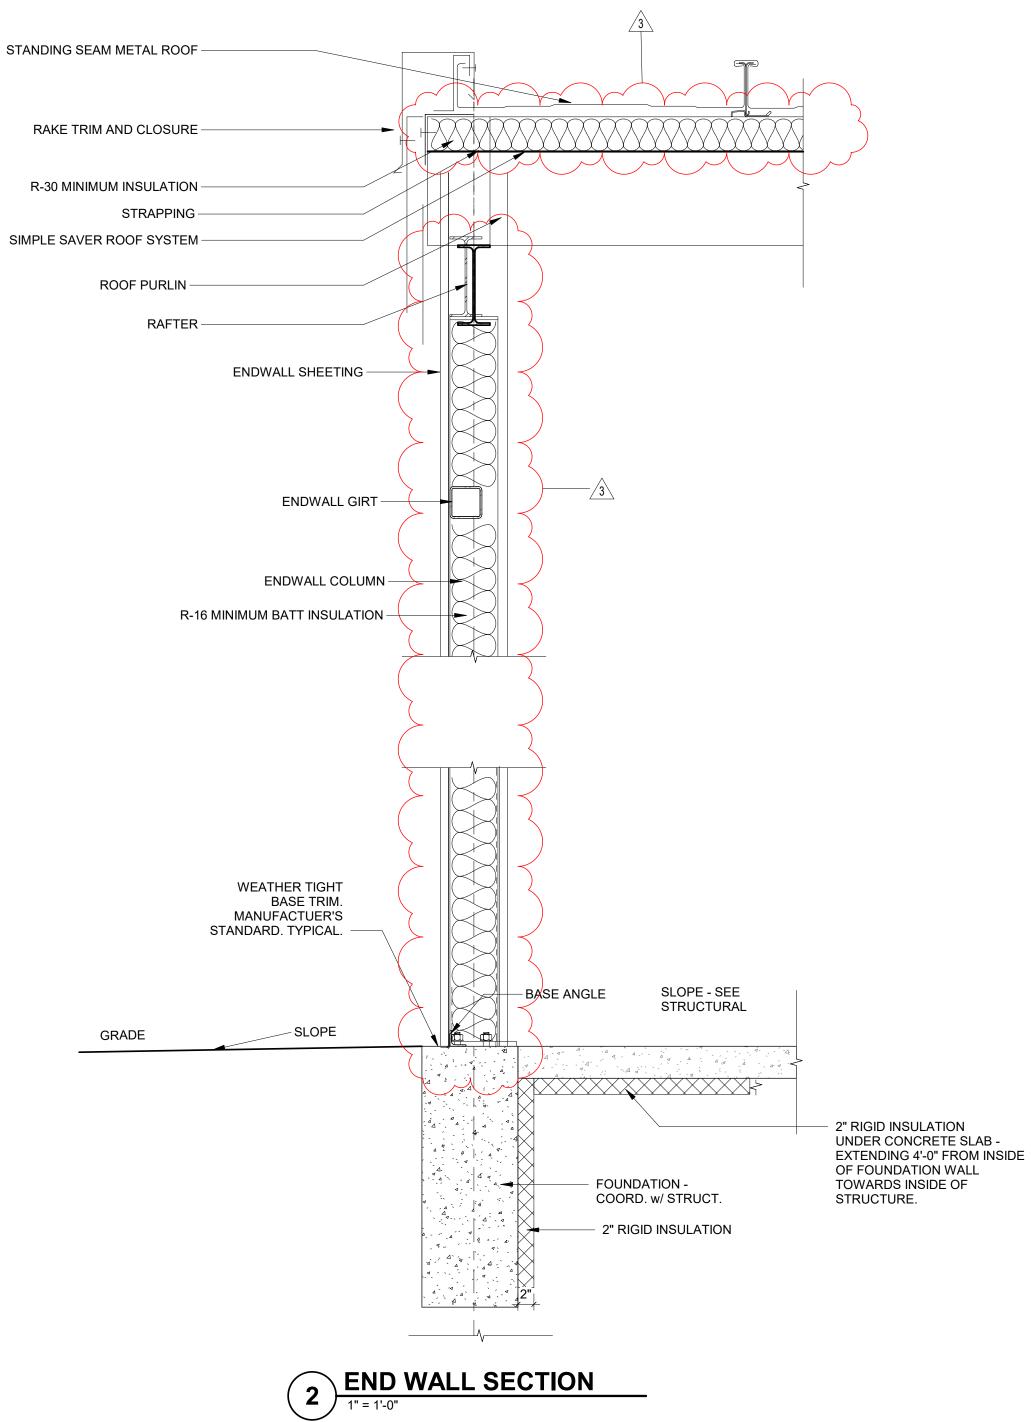



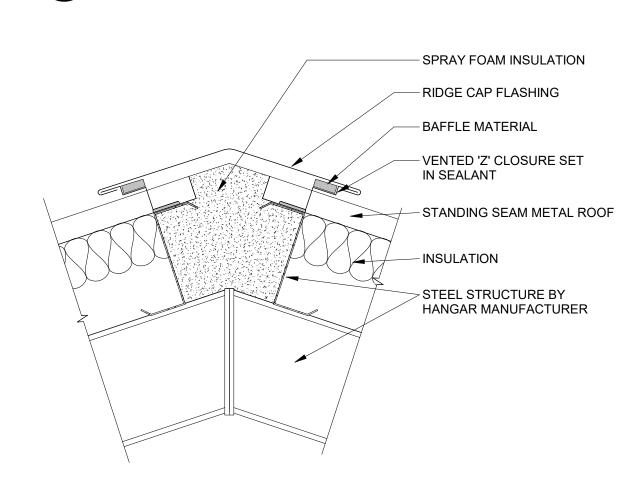

5 ROOF RIDGE DETAIL
1 1/2" = 1'-0"

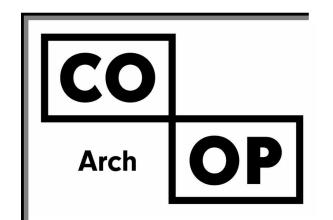


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REV. # REV. DSC. REV. DATE

ADDENDUM #1 04-15-2021

PROJECT:

WEBSTER T-HANGAR

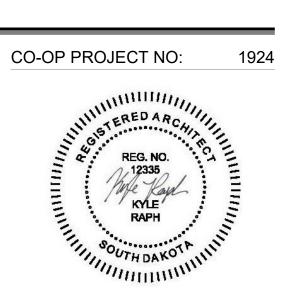WEBSTER, SOUTH DAKOTA

SHEET TITLE:

BUILDING DETAILS

A1-5